

COMMERCIAL SITE PLAN ROUTE 125 TAX MAP 223, LOT 26-57

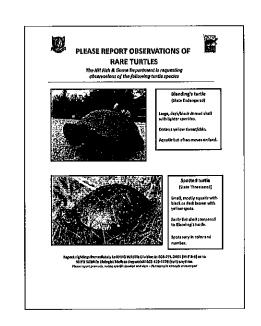

BLANDINGS & SPOTTED TURTLES HAVE BEEN REPORTED IN THE AREA. IF SPOTTED OR BLANDING'S TURTLES ARE FOUND LAYING EGGS IN THE WORK AREA, PLEASE CONTACT MELISSA DOPERALSKI AT 271-1738 or JOSH MEGYESY AT 271-1125 FOR FURTHER INSTRUCTIONS

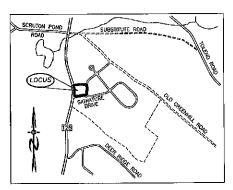

LOCATION MAP

NEW HAMPSHIRE FISH AND GAME ACT PERMIT CONDITIONS RELATED TO THREATENED AND ENDANGERED SPECIES

• ALL OBSERVATIONS OF THREATENED OR ENDANGERED SPECIES SHALL BE REPORTED IMMEDIATELY TO THE NEW HAMPSHIRE FISH AND GAME DEPARTMENT NONGAME AND ENDANGERED WILDLIFE ENVIRONMENTAL REVIEW PROGRAM BY PHONE AT 603-271-2461 AND BY EMAIL AT NHFOREVIEW-WWILDLIFE.NH.GOV. EMAIL SUBJECT LINE: NHB20-2876, PROJECT NAME, WILDLIFE SPECIES OBSERVATION. PHOTOGRAPHS SHALL BE PROVIDED FOR VERHEICATION AS FEASIBLE; AND

PROVIDED FOR VERHICATION AS FEASIBLE; AND

THE NEW HAMPSHIRE FISH AND GAME DEPARTMENT SHALL HAVE ACCESS TO THE PROPERTY DURING THE TERM OF THE PERMIT.

ALL MANUFACTURED EROSION AND SEDIMENT CONTROL PRODUCTS, UTILIZED FOR, BUT NOT LIMITED TO,

- ALL MANUFACTURED EROSION AND SEDIMENT CONTROL PRODUCTS, UTILIZED FOR, 8UT NOT LIMITED TO, SLOPE PROTECTION, RUNOFF DIVERSION, SLOPE INTERRUPTION, PERIMETER CONTROL, AND INLET PROTECTION, CHECK DAMS, SEDIMENT TRAPS, AND SILT FENCE INSTALLED IN ACCORDANCE WITH ENV-WQ 1506.04, SHALL NOT CONTAIN WELDED PLASTIC, PLASTIC, OR MULTI-FILAMENT OR MONOFILAMENT POLYPROPYLENE NETTING OR MESH.

PLAN INDEX

TITLE SHEET	
EXISTING CONDITIONS PLAN	1
PARKING/PAVEMENT PLAN	6
GRADING & DRAINAGE PLAN	ŗ
LIGHTING PLAN	4
LANDSCAPE PLAN	f
CONSTRUCTION DETAILS	6
EROSION & SEDIMENT	
CONTROL DETAILS	r



FEB 09 200

WETLAND/SOIL CONSULTANT:

GOVE ENVIRONMENTAL SERVICES INC. 8 CONTINENTAL DRIVE, BLDG 2 UNIT H EXETER, NH 03833 1-603-778-0644

LAND SURVEYORS:



CIVIL ENGINEERS:




70 PORTSMOUTH AVE, THIRD FLOOR, SUITE 2 STRATHAM, N.H. 03885 PHONE: 603-583-4860, FAX. 603-583-4863 OWNER: ROUTE 125 DEVELOPMENT, LLC JOSEPH FALZONE 7B EMERY LANE STRATHAM, N.H. 03885


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***	No. 4
REQUIRED PERMITS	
NHDES SEPTIC APPROVAL NUMBER: (PENDING) NHDES ALTERATION OF TERRAIN APPROVAL NUM	ABER: (PENDING

REVISIONS:	DATE:

NE-1144.1 SITE PLAN ISSUED FEB., 2022



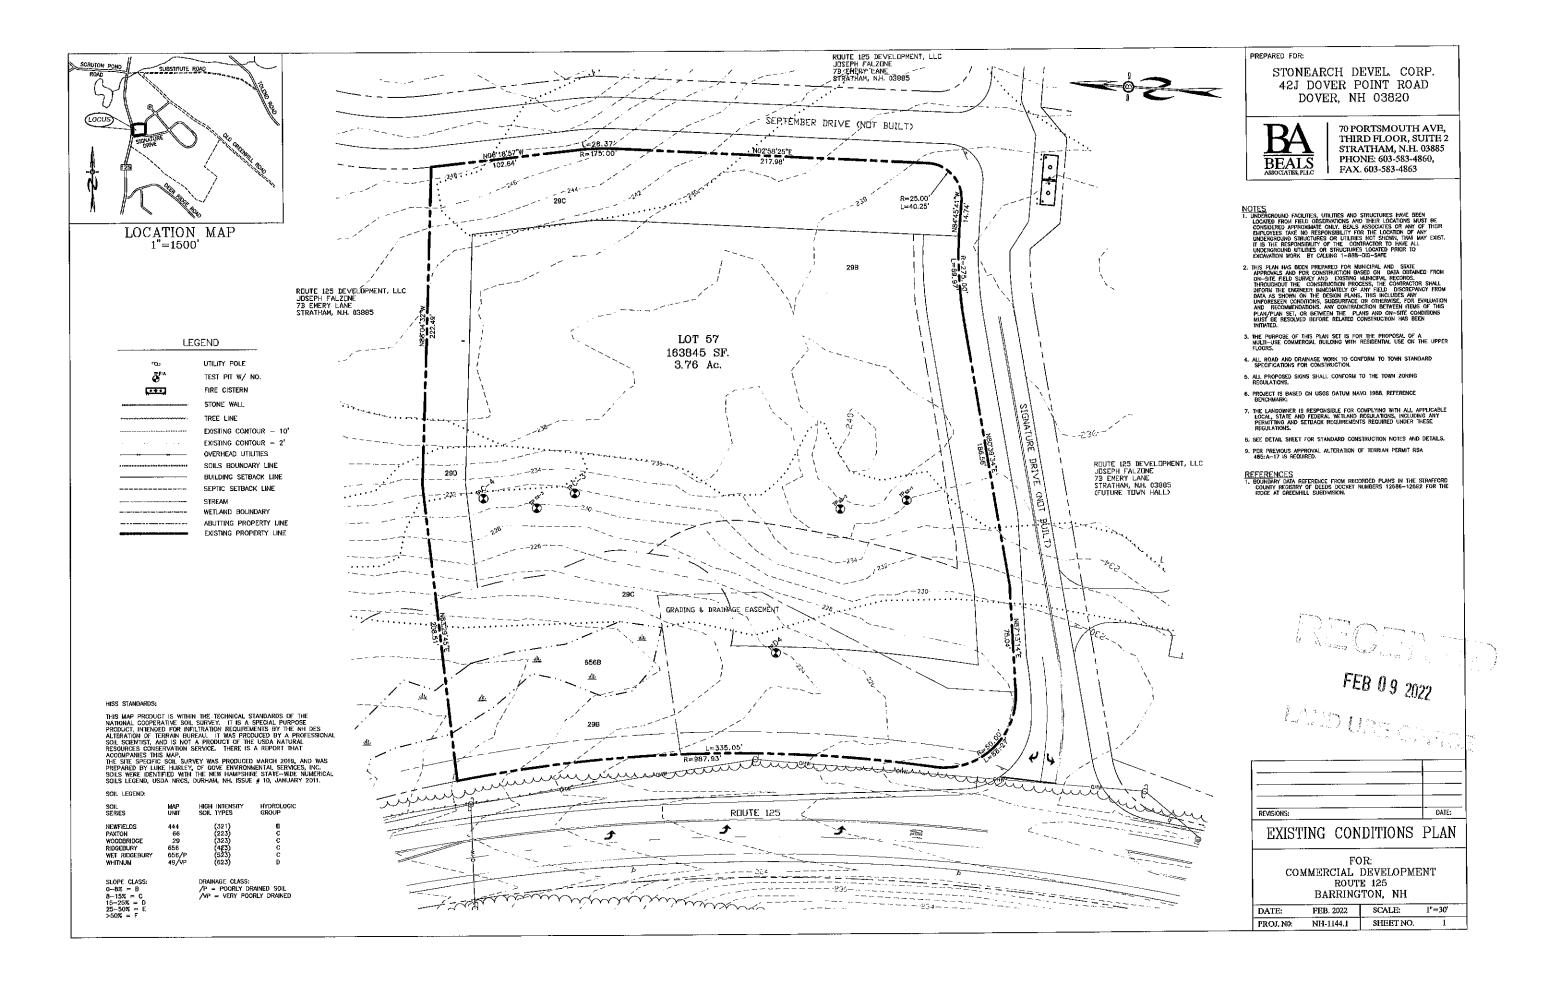

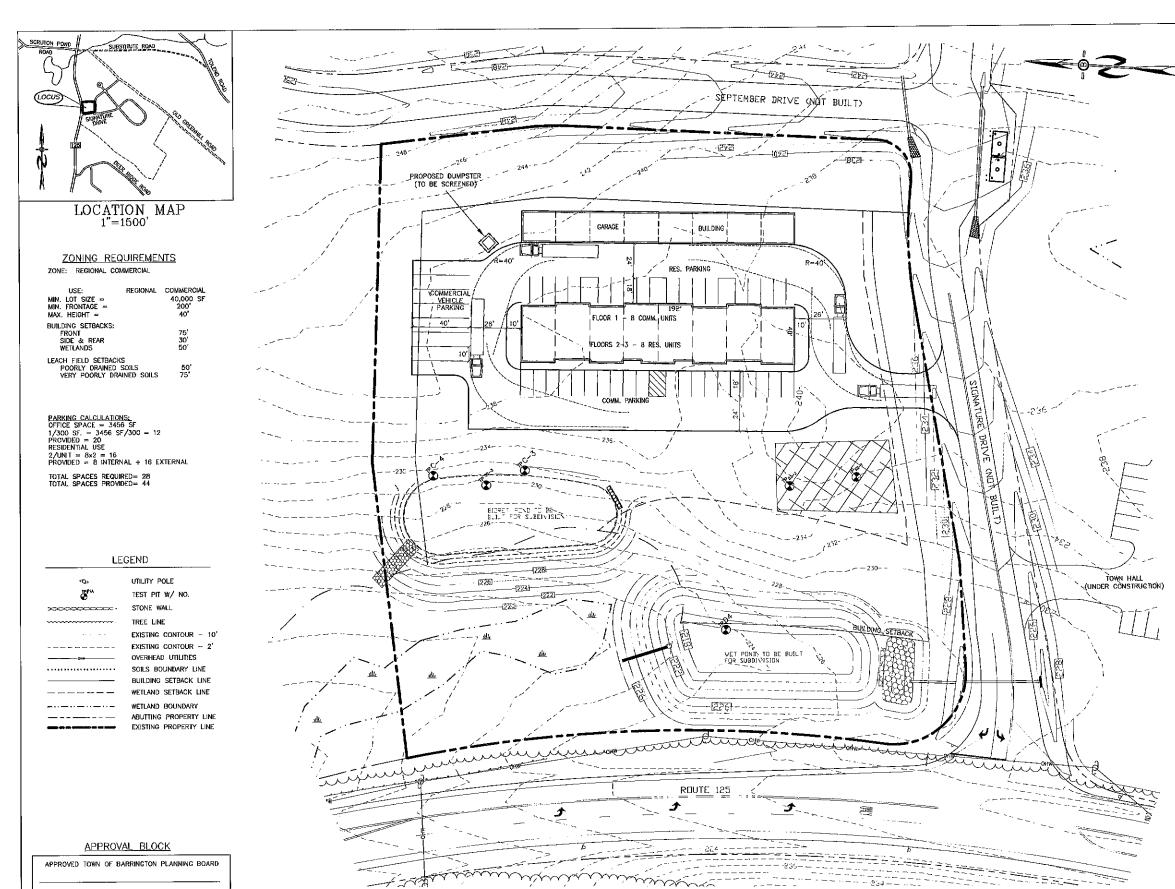CHAIRPERSON

DATE

PREPARED FO

STONEARCH DEVEL CORP. 42J DOVER POINT ROAD DOVER, NH 03820



70 PORTSMOUTH AVE, THIRD FLOOR, SUITE 2 STRATHAM, N.H. 03885 PHONE: 603-583-4860, FAX. 603-583-4863

NOTES

1. UNCERGROUND FACILITIES, UTILITIES AND STRUCTURES HAVE BEEN LOCATED FROM FIELD OBSERVATIONS AND THEIR LOCATIONS MUST BE CONSIDERED APPROXIMATE ONLY, BEALS ASSOCIATES OR NAY OF THEIR EMPLOYEES TAKE RESPONSIBILITY FOR THE LOCATION OF ANY UNDERGROUND STRUCTURES OR UTILITIES NOT SHOWN, THAT MAY EXST. IT IS THE RESPONSIBILITY OF THE CONSTRUCTOR TO HAVE ALL UNDERGROUND UTILITIES OR STRUCTURES LOCATED.

- 2. THIS PLAN HAS BEEN PREPARED FOR MUNICIPAL AND STATE APPROVAIS AND FOR CONSTRUCTION PASSED ON DATA OBTAINED FROM ON-STEE FIELD SURVEY AND EXISTING MUNICIPAL RECORDS. THROUGHOUT THE CONSTRUCTION PROCESS, THE CONTRACTOR SHALL INFORM THE ENCHAPTER IMMEDIATELY OF MAY FIELD DISCREPANCY FROM DATA AS SHORTHER DESCRIPTIONS, OF THE MUNICIPAL PROPERTY OF THE PLANS AND GIVEN FIELD OF THE PLANS AND FIELD OF THE PLANS AND GIVEN FIELD OF THE PLANS AND FIELD OF TH
- ALL BENCHMARKS AND TOPOGRAPHY SHOULD BE FIELD VERIFIED BY I CONTRACTOR.
- ALL ROAD AND DRAINAGE WORK TO CONFORM TO TOWN STANDAR SPECIFICATIONS FOR CONSTRUCTION.
- 5. ALL PROPOSED SIGNS SHALL CONFORM TO THE TOWN ZONING REGULATIONS.
- 5. PROJECT IS BASED ON USGS DATUM NAVD 1988. REFERENCE BENCHMARK:
- 7, THE LANDOWNER IS RESPONSIBLE FOR COMPLYING WITH ALL APPLICABLE LOCAL, STATE AND FEDERAL WETLAND REGULATIONS, INCLUDING ANY PERMITTING AND STATE AND RESPONSIBLE TO REPORT AND THE STATE OF THE RESPONSIBLE AND ASSAULTED AND THE STATE OF THE ADDRESS OF THE ADDRE
- 8. SEE DETAIL SHEET FOR STANDARD CONSTRUCTION NOTES AND DETAILS.
- 9. ALTERATION OF TERRIAN PERMIT RSA 485: A-17 IS REQUIRED.

 10. THIS SITE IS NOT LOCATED IN THE 100 YEAR FLOOD ZONE.

UNDERGROUND FACILITIES, UTILITIES AND STRUCTURES HAVE BEEN PLOTTED FROM DELD OBSERVATION AND THEIR LOCATION MUST BE CONSIDERED APPROXIMATE ONLY. NEITHER BEMLS ASSOCIATES, NOR ANY OF THEIR EMPLOYEES TAKE RESPONSIBILITY FOR THE LOCATION OF ANY UNDERGROUND STRUCTURES OF UTILITIES NOT SHOWN THAT MAY EXIST. IT IS THE RESPONSIBILITY OF THE CONTRACTOR TO HAVE ALL UNDERGROUND STRUCTURES AND/OR UTILITIES LOCATED PRIOR TO EXCAVATION

WORK BY CALLING 1-888-DIG-SAFE (1-888-344-7233).




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PARKING/PAVEMENT PLAN

COMMERCIAL DEVELOPMENT ROUTE 125 BARRINGTON, NH

DATE:	FEB. 2022	SCALE:	1"=30'
PROJ. NO:	NH-1144.1	SHEET NO.	2



LEGEND

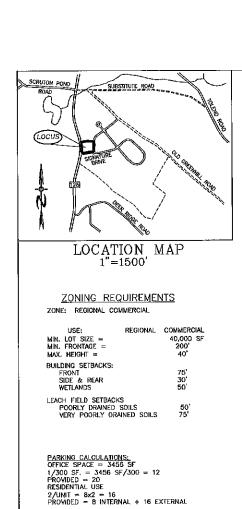TOTAL SPACES REQUIRED= 28 TOTAL SPACES PROVIDED= 44

TEST PIT W/ NO.

STONE WALL

TREE LINE


EXISTING CONTOUR - 10'
EXISTING CONTOUR - 2'
OVERHEAD UTILITIES
SOILS BOUNDARY LINE
BUILDING SETBACK LINE
WETLAND SETBACK LINE
WETLAND SETBACK LINE
WETLAND SOUNDARY
ABUITING PROPERTY LINE
EXISTING PROPERTY LINE
CXISTING PROPERTY LINE
ADOD SF SEPTIC
RESERVE AREA

PROP. WELL W/
75' PROTECTIVE RAD.

APPROVAL BLOCK

APPROVED TOWN OF BARRINGTON PLANNING BOARD

CHARPERSON DATE

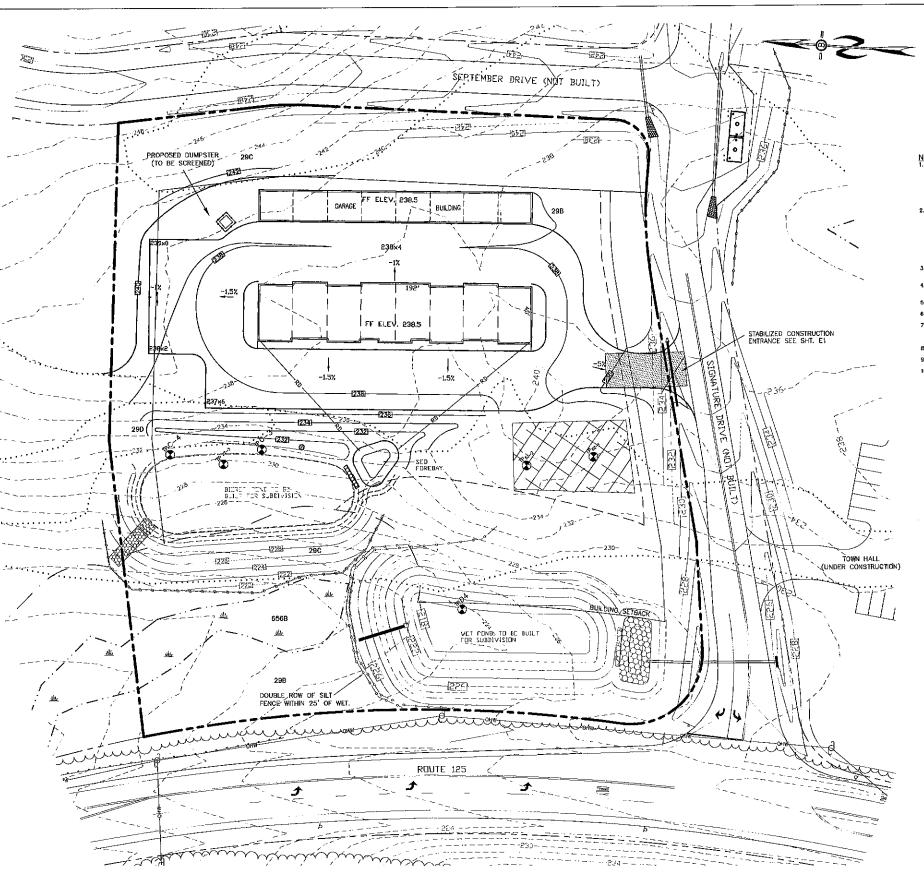

PREPARED FOR:

STONEARCH DEVEL. CORP. 42J DOVER POINT ROAD DOVER, NH 03820



70 PORTSMOUTH AVE, THIRD FLOOR, SUITE 2 STRATHAM, N.H. 03885 PHONE: 603-583-4860, FAX. 603-583-4863

NOTES

ILS2
MINDERGROUND FACILITIES, UTILITIES AND STRUCTURES HAVE BEEN LOCATED
FROM FIELD DESERVATIONS AND THEIR LOCATIONS MUST BE CONSIDERED
APPROXIMATE ONLY, BEALS ASSOCIATES OR ANY OF THEIR REPLOYEES TAKE NO
RESPONSIBILITY FOR THE LOCATION OF ANY UNDERGROUND STRUCTURES OR
UNLINES NOT SHOWN, THAT MAY EXIST. IT IS THE RESPONSIBILITY OF THE
CONTRACTOR TO HAVE ALL UNDEFORCUND UTILITIES OR STRUCTURES LOCATED
PRIOR TO EXCAMATION WORK BY CALLING IT-88B-910G-840.

- 2. THIS PIAM HAS BEEN PREPARED FOR MUNICIPAL AND STATE APPROVAS AND FOR CONSTRUCTION BASED ON DATA OBTININE FROM ON-SITE PIELD SUPPRE AND EXISTING MUNICIPAL RECORDS, THROUGHOUT THE CONSTRUCTION PROCESS, THE CONTRICTOR SHALL INFORM THE ENDINEER MINEMATELY OF HAY FIELD DISCREPANCY FROM DATA AS SHOWN ON THE USSUE PLANS THOUGHOUT THE CONTRICTOR CONTRICTOR DISSREPANCY FROM DATA AS SHOWN ON THE USSUE PLANS THOUGHOUT SHOW INFORMED CONTRICTOR DISSREPANCY FROM DATA AS SHOWN ON THE USSUE PLANS THE CONTRICTOR DESIGNATION OF THE PLANS OF THE PERSON OF THE PERSON OF THE PERSON FOR ENTERED FOR THE PLANS AND ON-SITE CONDITIONS.
- 3. ALL BENCHMARKS AND TOPOGRAPHY SHOULD BE FIELD VERIFIED BY T
- ALL ROAD AND DRAINAGE WORK TO CONFORM TO TOWN STANDARD SPECIFICATIONS FOR CONSTRUCTION.
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- 9. ALTERATION OF TERRIAN PERMIT RSA 485: A-17 IS REQUIRED.
- 10. THIS SITE IS NOT LOCATED IN THE 100 YEAR FLOOD ZONE.

DWN NOTES

QUAING CONSTRUCTION, IT BECOMES APPARENT THAT DEFICIENCIES EXIST
THE APPROVED DESIGN DEAMINGS, THE CONTRACTOR SHALL BE REQUIRE
CORRECT THE DEFICIENCIES TO MEET THE REQUIREMENTS OF THE
CULLIFORMS AT AN EXPENSE TO THE TOWN.

REQUIRED EROSION CONTROL MEASURES SHALL BE INSTALLED PRIOR TO A DISTURBANCE OF THE SITE AND SHALL BE MANTAINED TIREOUGH THE COMPLETION OF ALL CONSTRUCTION ACTIVITIES. IF, DURING CONSTRUCTION EDUCATION OF A STATE OF THE CONTROL OF THE CONSTRUCTION STEED AND THE CON

ALL MATERIALS AND METHODS OF CONSTRUCTION SHALL CONFORM TO TOV OF BARRINGTON SUBDIVISION REGULATIONS AND THE LATEST EDITION OF TI NEW HAMPSHIRE DEPARTMENT OF TRANSPORTATION STANDARD SPECIFICATION FOR PAGE & ERPICE CONSTRUCTION


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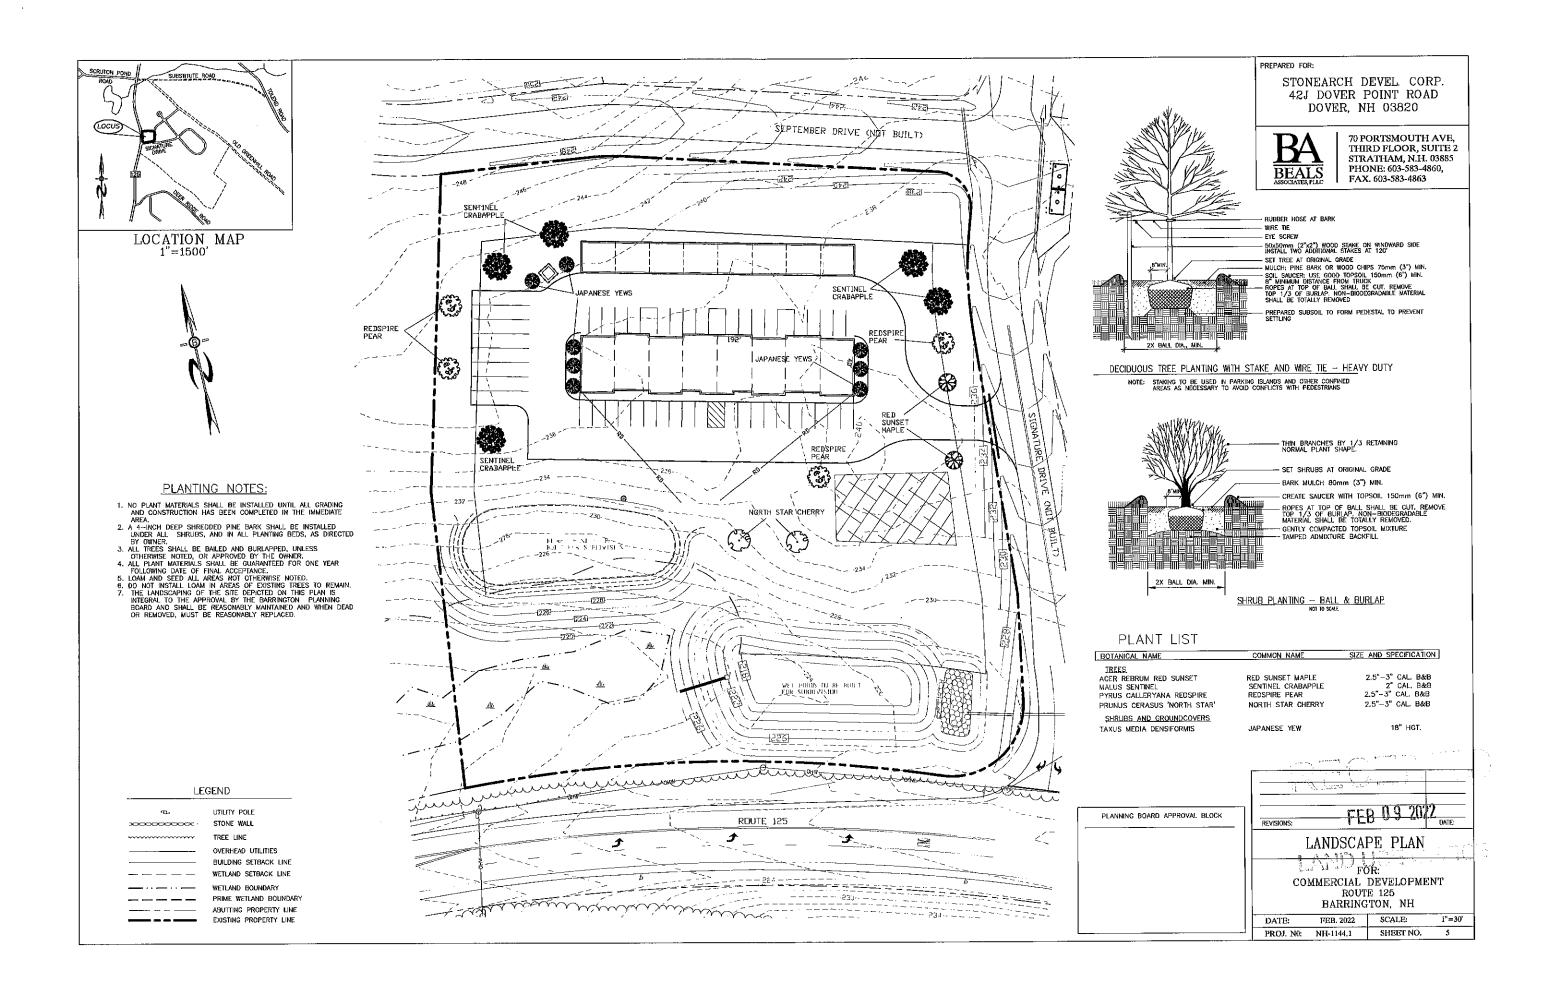
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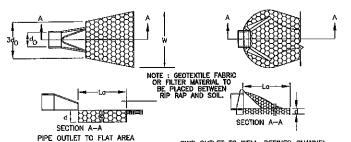
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FOR: COMMERCIAL DEVELOPMENT ROUTE 125 BARRINGTON, NH

DATE: FEB. 2022 SCALE: 1"=30'
PROJ. NO: NH-1144.1 SHEET NO. 3





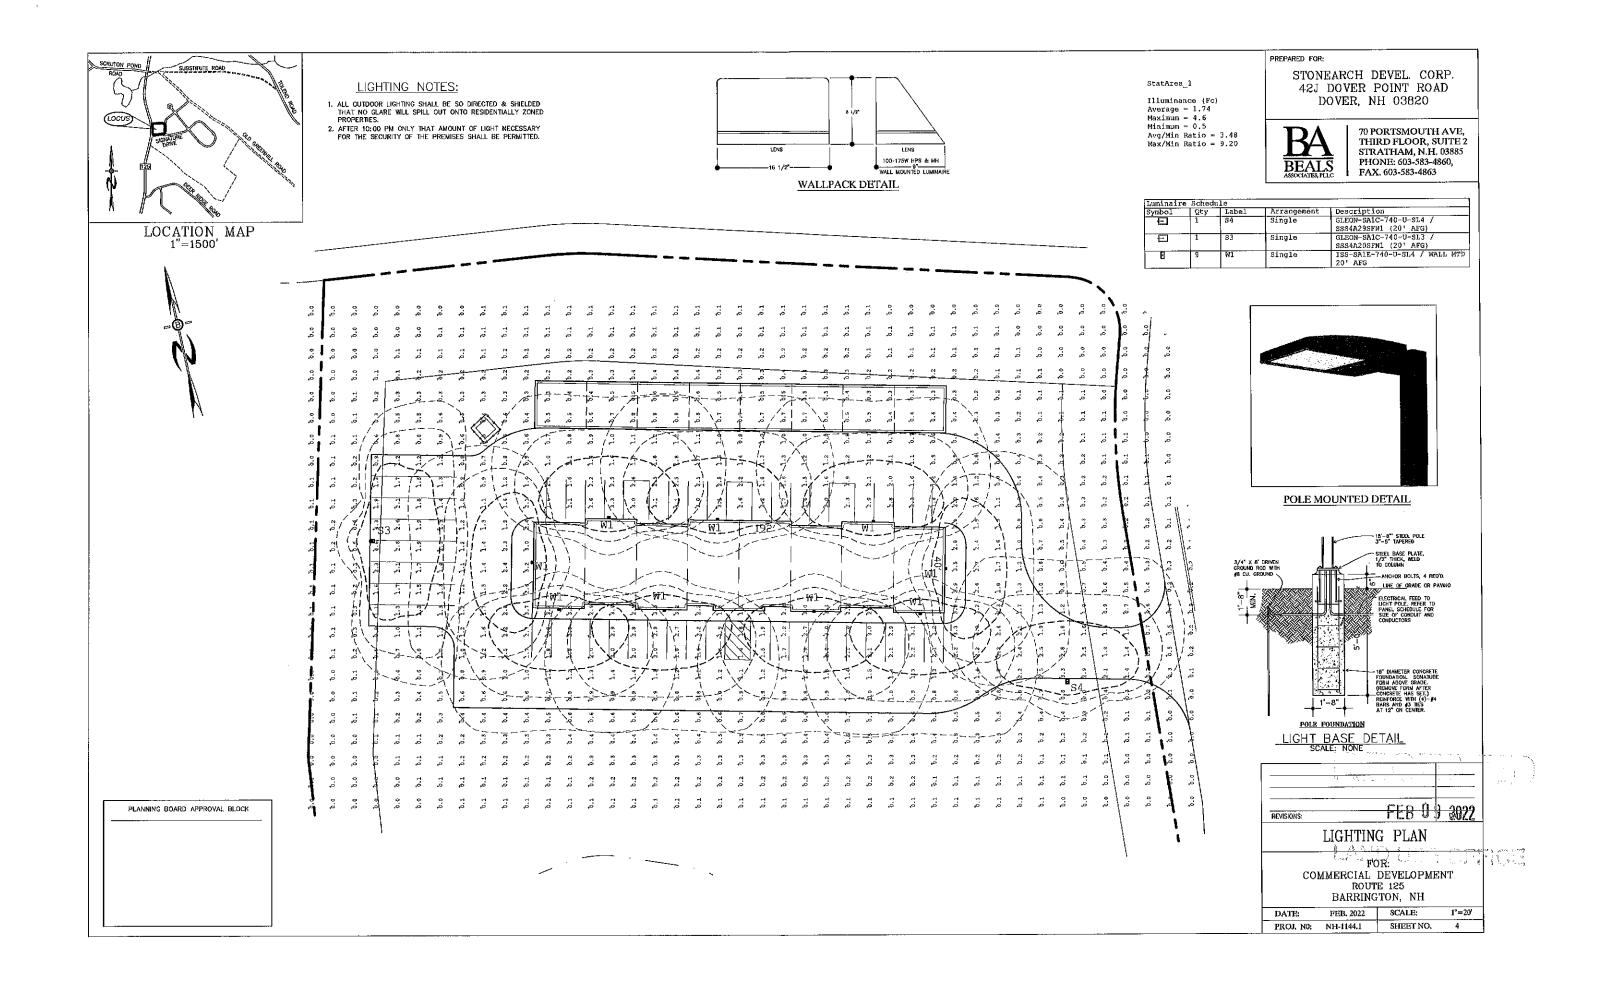

PIPE OUTLET TO WELL-DEFINED CHANNEL WITH NO DEFINED CHANNEL

WITH NO DEFINED CHANNEL

CONSTRUCTION SPECIFICATIONS

1. THE SUB GRADE FOR THE FILTER MATERIAL, GEOTEXTILE FABRIC, AND RIP RAP SHALL BE PREPARED TO THE LINES AND GRADES SHOWN ON THE PLANS.

2. THE ROCK OR GRAVEL USED FOR FILTER OF RIP RAP SHALL CONFORM TO THE SPECIFIED GRADATION. 3. GEOTEXTILE FABRICS SHALL BE PROTECTED FROM PUNCTURE OR TEARING DURING THE PLACEMENT OF THE ROCK RIP RAP. DAMAGED AREAS IN THE FABRIC, ALL OVERLAPS REQUIRED FOR REPAIRS OR JOINING TWO PIECES OF FABRIC SHALL BE RAPINGEMENT OF THE FABRIC, ALL OVERLAPS REQUIRED FOR REPAIRS OR JOINING TWO PIECES OF FABRIC SHALL BE A MINIMUM OF 12 INCHES.

4. STONE FOR THE RIP RAP MAY BE PLACED BY EQUIPMENT AND SHALL BE CONSTRUCTED

TO THE FULL LAYER THICKNESS IN ONE OPERATION AND IN SUCH A MANNER AS TO PREVENT SEGREGATION OF THE STONE SIZES.

5. STONE FOR RIRAP SHALL BE ANGULAR OR SUBANGULAR. THE STONES SHOULD BE SHAPED SO THAT THE LEAST DIMENSION OF THE STONE SHALL BE NOT LESS THAN ONE—THIRD OF THE GREATEST DIMENSION OF THE FRAGMENT,


6. FLAT ROCKS SHALL NOT USED FOR RIP RAP. VOIDS IN THE ROCK RIPRAP SHOULD BE FILLED WITH SPALLS AND SMALLER ROCKS.


MAINTENANCE

MAINTENANCE


1. THE OUTLET PROTECTION SHOULD BE CHECKED AT LEAST ANNUALLY AND AFTER EVERY MAJOR STORM. IF THE RIP RAP HAS 1. THE OUTLET SHOULD BE CHANNED OR DAMAGED, IT SHOULD BE REPAIRED IMMEDIATELY. THE CHANNEL IMMEDIATELY BELOW THE OUTLET SHOULD BE CHECKED TO SEE THAT EROSION IS NOT OCCURRING. THE DOWNSTREAM CHANNEL SHOULD BE KEPT CLEAR OF OBSTRUCTIONS SUCH AS FALLEN TREES, DEBTIS, AND SEDIMENT THAT COULD CHANGE FLOW PATTERNS AND/OR TALLWATER DEPTHS ON THE PIPES. REPAIRS MUST BE CARRIED OUT IMMEDIATELY TO AVOID ADDITIONAL DAMAGE TO OUTLET PROTECTION.

PIPE DUTLET PROTECTION

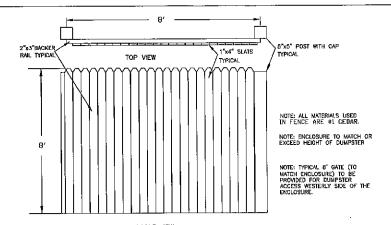


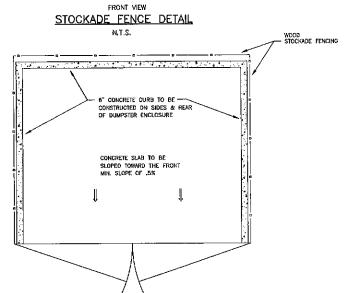

DUMPSTER SLAB DETAILS

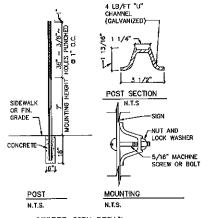


STREET SIGN DETAIL STOP SIGN (R)-1) 30" x 30"

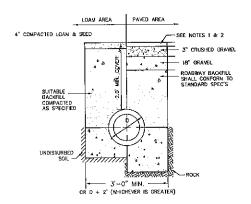

1. PAVEMENT REPAIR IN EXISTING ROADWAYS SHALL CONFORM TO STREET OPENING REGULATIONS.
2. NEW ROADWAY CONSTRUCTION SHALL CONFORM TO SUBDIVISION SPECIFICATIONS.


TYPICAL DRAINAGE TRENCH NOT TO SCALE

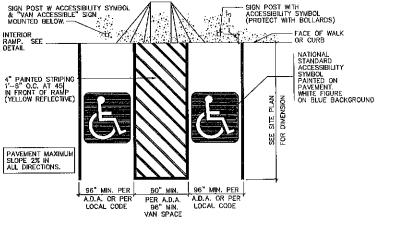

PARKING STALL FOR THE PHYSICALLY CHALLENGED

NOT TO SCALE

DEC. 15, 1991

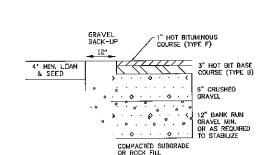

NOTE: IN AREAS OF ROCK EXCAVATION, MINIMUM 9"
BANK RUN GRAVEL SHALL BE PLACED

TYPICAL PAVEMENT SECTION NEW ASPHALT - NTS

PREPARED FOR:

STONEARCH DEVEL. CORP. 42J DOVER POINT ROAD DOVER, NH 03820



70 PORTSMOUTH AVE, THIRD FLOOR, SUITE 2 STRATHAM, N.H. 03885 PHONE: 603-583-4860, FAX. 603-583-4863


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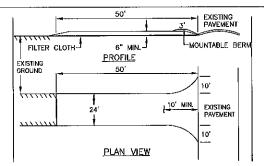
DATE: REVISIONS:

CONSTRUCTION DETAILS D1

COMMERCIAL DEVELOPMENT ROUTE 125 BARRINGTON, NH

DATE:	FEB 2022	SCALE: NTS
PROJ. N0:	NH-1144.1	SHEET NO. 6



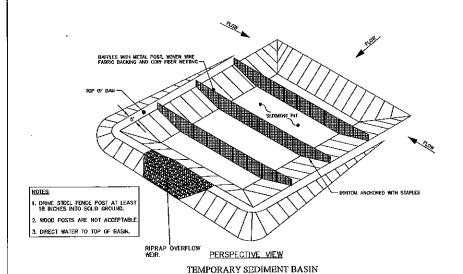

1. STONE FOR A STABILIZED CONSTRUCTION ENTRANCE SHALL BE 3 INCH STONE, RECLAIMED STONE, OR

1. STONE FOR A STABILIZED CONSTRUCTION ENTRANCE SHALL BE 3 INCH STONE, RECLAIMED STONE, OR RECYCLED CONCRETE EQUIVALENT.

2. THE LENGTH OF THE STABILIZED ENTRANCE SHALL NOT BE LESS THAN SO FEET, EXCEPT FOR A SINGLE RESIDENTIAL LOT WHERE A 30 FOOT MINIMUM LENGTH WOULD APPLY.

3. THE THICKNESS OF THE STONE FOR THE STABILIZED ENTRANCE SHALL NOT BE LESS THAN 6 INCHES.

4. THE WIDTH OF THE ENTRANCE SHALL NOT BE LESS THAN THE FULL WIDTH OF THE ENTRANCE WHERE INCRESS OF ECRESS OCCURS OR 10 FEET, WHICH EVER IS GREATER. 5. GEOTEXTILE FILTER CLOTH SHALL BE PLACED OVER THE ENTIRE REA PRIOR TO PLACING THE STONE, FILTER CLOTH IS THAT IS FLOWING TO GO DIVERTED TOWARD THE CONSTRUCTION ENTRANCE SHALL SURFACE WATER THAT IS FLOWING TO OR DIVERTED TOWARD THE CONSTRUCTION ENTRANCE SHALL BE PIPED BENEATH THE ENTRANCE. IF PIPING IS IMPRACTICAL, A BERM WITH 5:1 SLOPES THAT CAN BE CROSSED BY VEHICLES MAY BE, SUBSTITUTED FOR THE PIPE.

7. THE ENTRANCE SHALL BE MANTAINED IN A CONDITION THAT WILL PREVENT TRACKING OR FLOWING OF SEDIMENT ONTO PUBLIC RIGHTS—OF—WAY. THIS MAY REQUIRE PERIODIC TOP DRESSING WITH ADDITIONAL STONE AS CONDITIONS DEMAND AND REPAIR AND/OR CLEAN OUT OF ANY MEASURES USED TO TRAP SEDIMENT. ALL SEDMENT SPILLED, WASHED, OR TRACKED ONTO PUBLIC RIGHT—OF—WAY MUST BE REMOVED PROMPHLY.

STABILIZED CONSTRUCTION ENTRANCE

TEMPORARY EROSION CONTROL MEASURES

1. THE SHAULEST PRACTICAL AREA SHALL BE DISTURBED DURING CONSTRUCTION, BUT NO MORE THAN 5 ACRES OF LAND SHALL BE EXPOSED BEFORE DISTURBED AREAS ARE STABILIZED.

- PERMINETER CONTROLS MUST BE INSTALLED PRIOR TO BASH MOVING OPERATIONS.

- STORMWATER PONDS, INFILITATION BASINS AND SWALES MUST BE INSTALLED BEFORE ROUGH GRADING THE SITE.

- runoff must be directed to temporary practices until stormwater bmps are stabilized. Stormwater ponds, infiltration basins and swales must be stabilized prior to directing runoff to them.
- FROSION CONTROL PRACTICES ARE TO BE INSPECTED WEEKLY AND ACTOR 0.5. OF RAINFALL
- CUT AND FILE SLOPES MUST BE STABILIZED WITHIN 72 HOURS OF ACHIEVING FINISHED GRADE

ROADWAYS AND PARKING AREAS MUST BE STABLIZED WITHIN 22 HOURS OF ACTIONING TINOHED GRADE.

2. EROSION, SEDMENT AND DETENTION HEASURES SHALL BE INSTALLED AS SHOWN ON THE PLANS AND AT LOCATIONS AS REQUIRED OR DIRECTED BY THE ENGINEER ALL DISTURBED AREAS SHALL BE RETURNED TO ORIGINAL GRADES AND ELEVATIONS.

3. DISTURBED AREAS SHALL BE LOAMED WITH A MINIMAN OF 4° OF LOAM AND SEEDED WITH NOT LESS THAN 1.10 POUNDS OF

SEED PER 1000 SQUARE FEET OF AREA. (48 POUNDS PER ACRE) SEE SEED SPECIFICATIONS THIS SHEET.

4. SILT FENCES AND OTHER EROSION CONTROLS SHALL BE INSPECTED WEEKLY AND AFTER EVERY RAIN EVENT GREATER THAN

0.5" DURING THE LIFE OF THE PROJECT, ALL DAMAGED AREAS SHALL BE REPAIRED, SEDIMENT DEPOSITS SHALL PERIODICALLY

BE REMOVED AND DISPOSED OF.

5. AFTER ALL DISTURBED AREAS HAVE BEEN STABILIZED, THE TEMPORARY EROSION CONTROL MEASURES ARE TO BE REMOVED.

5. ATER ALL DISTURBED AREAS HAVE BEEN STABILEZD, THE TEMPORARY EROSION CONTROL MEASURES ARE TO BE REMOVED AND THE REACH DISTURBED BY THE REMOVAL SMOOTHED AND RE-VEGETIAND. PERMANENTLY STABILEZED WITHIN 15 DAYS OF FINAL GRADING, OR TEMPORARILY STABILEZED WITHIN 15 DAYS OF FINAL GRADING, OR TEMPORARILY STABILEZED WITHIN 16 DAYS OF MITHIAL DISTURBANCE OF SOIL.

* AN AREA SHALL BE CONSIDERED STABLE IF ONE OF THE FOLLOWING HAS OCCURRED:

- IN AREAS TO BE PAVED, ASSE COURS GRAVES MEETING THE REQUIREMENTS OF INHOIS STANDARD FOR ROAD AND BUILDED CONSTRUCTION, 2016, IREM 3012 MOVE SEEN INSTALLED.

- A LINIMALIA OF 5 BIOCHES OF NON-PROSVE WATERIAN SUCH AS RIPRAP HAS BEEN INSTALLED.

- EROSION CONTROL BLANKETS HAVE BEEN PROPERLY INSTALLED.

- CONSTRUCTION SPECIFICATIONS

 1. STRUCTURES SHALL BE INSTALLED ACCORDING TO THE DIMENSIONS SHOWN ON THE PLANS AT THE APPROPRIATE SPACING.

 2. CONSTRUCTION OPERATIONS SHALL BE CARRIED OUT IN SUCH A MANNER SO THAT EROSION AND AIR AND
- WATER POLLUTION WILL BE MINIMIZED.

 3. WHEN TIMBER STRUCTURES ARE USED, THE TIMBER SHALL EXTEND AT LEAST 18" INTO THE SOIL.
- 5. STEAM BALES SHALL BE ANCHORED INTO THE SOIL USING 2" X 2" STAKES DRIVEN THROUGH THE BALES AND AT LEAST 18 INCHES IN TO THE SOIL.

 5. SEEDING, FERTILIZING, AND MULCHING SHALL CONFORM TO THE RECOMMENDATIONS IN THE APPROPRIATED
- 5. SEDING, FERTILIZING, AND MULCHING SHALL CONFORM TO THE RECOMMENDATIONS. IN THE APPROPRIATED VEGETATIVE BMP.

 6. STRUCTURES SHALL BE REMOVED FROM THE CHANNEL WHEN THEIR USEFUL LIFE. HAS BEEN COMPLETED.

 7. THROUGHOUT THE DURATION OF CONSTRUCTION ACTIVITIES THE CONTRACTOR SHALL TAKE PRECAUTIONS AND INSTRUCTIONS FROM THE PLANNING DEPARTMENT. IN ORDER TO PREVENT, ABATE AND CONTROL THE EMISSION OF FUGITIVE DUST INCLUDING BUT NOT LIMITED TO WETTING, COVERING, SHELDING, OF VACUUMING. B. THE INTECOMMISSIONER OF AGRICULTURE PROHBITS THE COLLECTION, POSSESSION, IMPORTATION, TRANSPORTATION, SALE, PROPAGATION, TRANSPLANTATION, OR CULTIVATION OF PLANTS BANNED BY NH LAW RSA 430:53 AND NH CODE ADMINISTRATIVE RULES AGR. 3800. THE PROJECT SHALL MEET ALL REQUIREMENTS AND THE INTENT OF . RSA 430:53 AND AGR 3800 RELATIVE TO INVASIVE SPECIES.

 9. IN THE EVENT THAT GREATER THAN ONE ACRE OF CONTIGUOUS DISTURBANCE OCCURS, THE CONSTRUCTION SIZE OPERATOR AND OWNER SHALL SUBBILT AND TO POUR TO NOT TO USERPA.
- IN THE EYEN THAT GREATER THAN OWNER SHALL SUBMIT A NOTICE OF INTENT (NOI) TO USEPA, WASHINGTON, DC, STORNWATER NOTICE PROCESSING CENTER AT LEAST FOURTEEN DAYS PRIOR TO COMMENCEMENT OF WORK ON SITE. EPA WILL POST THE NOI AT
- HERMIT ONCE THE NOI IS SHOWN IN "ACTIVE STATUS".

CONSTRUCTION SEQUENCE

CONSTRUCTION SEQUENCE.

1. CUT AND REMOVE TREES IN CONSTRUCTION AREAS AS REQUIRED OR DIRECTED.

2. CONSTRUCT AND/OR INSTALL TEMPORARY AND PERMANENT SEDIMENT EROSION AND DETENTION CONTROL FACILITIES AS REQUIRED. EROSION, SEDIMENT AND DETENTION CONTROL FACILITIES STALL BE INSTALLED AND STABILIZED PRIOR TO ANY EARTH MOVING OPERATION AND PRIOR TO DIRECTING RUNOFF TO THEM.

3. CLEAR, CUT, GRUB AND DISPOSE OF DEBRIS IN APPROVED FACILITIES. STUMPS AND DEBRIS ARE TO BE REMOVED FROM SITE AND DISPOSED OF PER STATE AND LOCAL REGULATIONS.

4. EXCANAGE AND STOCKHEE TOPSOIL, CACM, ALL AREAS SHALL BE STABILIZED IMMEDIATELY AFTER GRADING.

5. CONSTRUCT TEMPORARY CULVERTS AS REQUIRED OR DIRECTED.

4. EAGWARE AND STOCKPILE TOP-SOIL, /LOAM, ALL AREAS SHALL BE STABILIZED IMMEDIATELY AFTER GRADING.
5. CONSTRUCT TEMPORARY CULYERIS AS REQUIRED OR DIRECTED.
6. CONSTRUCT THE ROADWAY AND ITS ASSOCIATED DRAINAGE STRUCTURES, ALL ROADWAYS, AND CUT/FILL SLOPES SHALL BE STABILIZED AND/OR LOAMED AND SEEDED WITHIN 72-HOURS OF ACHIEVING FINISH GRADE AS APPLICABLE.
7. INSTALL PIPE AND CONSTRUCTION ASSOCIATED APPURTENANCES AS REQUIRED OR DIRECTED. ALL DISTURBED AREAS SHALL STRADIRETY AND TEMPORARY SEEDING AND MULCHING, ALL CUT AND FILL SLOPES AND DISTURBED AREAS SHALL BE SEEDED OR MULCHED AS REQUIRED, OR DIRECTED.
9. DAILY OR AS REQUIRED, CONSTRUCT TEMPORARY BERNS, DRAINAGE CHECK DAMS, DITCHES, SEDIMENT TRAPS, ETC.
10. INSPECT AND MAINTAIN ALL EROSION AND SEDIMENT CONTROL MEASURES DURING CONSTRUCTION
11. COMPLETE PERMANENT SEEDING AND LANDSCAPING
12. REMOVE TEMPORARY EROSION ON AND LANDSCAPING
13. REMOVE TEMPORARY EROSION CONTROL MEASURES AFTER SEEDING AREAS BAYE ESTABLISHED THEMSELVES AND STEE IMPROVEMENTS ARE COMPLETE. SMOOTH AND REVEGETATE ALL DISTURBED AREAS.
15. ALL SWALES AND DRAINAGE STRUCTURES WILL BE CONSTRUCTED AND STABILIZED PRIOR TO HAVING RUNOFF DIRECTED. TO THEM.

DIRECTED TO THEM.

14. FINSH PAYING ALL ROADWAYS.

15. LOT DISTURBANCE OTHER THAN THAT SHOWN ON THE APPROVED PLANS SHALL NOT COMMENCE UNTIL THE ROADWAY HAS THE CRUSHED STONE COURSE TO DESIGN ELEVATION/REQUIRED COMPACTION AND THE ASSOCIATED DEPARTMENT OF COURSE TO DESIGN ELEVATION/REQUIRED COMPACTION AND THE ASSOCIATED DEPARTMENT OF COURSE TO THE ASSOCIATED DEPARTMENT OF THE PROPERTY OF THE ASSOCIATED DEPARTMENT OF THE

PHYSICAL SPECIFICATIONS (ROLL) WIDTH = 7.5' LENGTH = 120.0WEIGHT = 37 LBS. AREA = 100 SQUARE YARDS /BLANKET IN CENTER OF SWALE OR EXTEND UP 2:1 SIDE SLOPE AS SHOWN ON SITE PLANS Х Х ROADWAY CROSS-SECTION East Coast Erosion Blanket ECC-2B (Double Net Coconut) STAPLE PATTERN "2" INSTALLATION DETAIL

WINTER MAINTENANCE

1. ALL DISTURBED AREAS THAT DO NOT HAVE AT LEAST 85% VEGETATIVE COVERAGE PRIOR TO OCTOBER 15TH, SHALL BE STABILIZED BY APPLYING MULCH AT A RATE OF 3-4 TONS PER ACRE. ALL SIDE SLOPES, STEEPER THAN 4:1, THAT ARE NOT DIRECTED TO SWALES OR DETENTION BASINS, SHALL BE LINED WITH BIODEGRADABLE/PHOTODEGRADABLE "JUTE MATTING" (EXCELSIOR'S CURIEX II OR EQUAL). ALL OTHER SLOPES SHALL BE MULCHED AND TACKED AT A RATE OF 3-4 TONS PER ACRE. THE APPLICATION OF MULCH AND/OR JUTE MATTING SHALL NOT OCCUR OVER EXISTING SNOW COVER, IT THE SITE IS ACTIVE ATTER NOVEMBER 15TH, ANY SNOW THAT ACCUMULATES ON DISTURBED AREAS SHALL BE REMOVED. PRIOR TO SPRING THAW ALL AREAS WILL BE STABILIZED, AS DIRECTED ABOVE.

2. ALL SWALES THAT DO NOT HAVE FULLY ESTABLISHED VEGETATION SHALL BE EITHER LINED WITH TEMPORARY JUTE MATING OR TEMPORARY STONE CHECK DAMS (APPROPRIATELY SPACED). STONE CHECK DAMS WILL BE MAINTAINED THROUGHOUT THE WINTER MOINTS. IF THE SWALES ARE TO BE MATTED WITH FERMANENT LINERS OR RIPRAP WITH REGISTERING FABRIC, THIS SHALL BE COMPLETED PRIOR TO WINTER SHUTDOWN OR AS SOON AS THEY ARE PROPERTY.

3. PRIOR TO OCT, 15TH ALL ROADWAY AND PARKING AREAS SHALL BE BROUGHT UP TO AND THROUGH THE BANK RUN GRAVEL APPLICATION. IF THESE AREAS' ELEVATIONS ARE PROPOSED TO REMAIN BELOW THE PROPOSED SUBGRADE ELEVATION, THE SUBGRADE MATERIAL SHALL BE ROUGHLY CROWNED AND A 3" LAVER OF CRUSHED GRAVEL SHALL BE PLACED AND COMPACTED. THIS WILL ALLOW THE SUBGRADE TO SHED RUNOFF AND WILL BEDUCE ROADWAY EROSION. THIS CRUSHED GRAVEL DOES NOT HAVE TO CONFORM TO NH DOT 304.3, BUT SHALL HAVE BETWEEN 15-25% PASSING THE #200 SIEVE AND THE LARGEST STONE SIZE SHALL BE 2". IF THE SITE IS ACTIVE AFTER NOVEMBER 15TH, ANY ACCUMULATED SNOW SHALL BE REMOVED FROM ALL ROADWAY AND PARKING AREAS.

4. AFTER OCTOBER 15TH, THE END OF NEW HAMPSHIRE'S AVERAGE GROWING SEASON, NO ADDITIONAL LOAM SHALL BE SPREAD ON SIDE SLOPES AND SWALES. THE STOCKPILES THAT WILL BE LEFT UNDISTURBED UNTIL SPRING SHALL BE SEEDED BY THIS DATE. AFTER OCTOBER 15TH, ANY NEW OR DISTURBED PILES SHALL BE MULCHED AT A RATE OF 3-4 TONS PER ACRE. ALL STOCKPILES THAT WILL REMAIN THROUGHOUT THE WINTER SHALL BE SURROUNDED WITH SHIT FENCING.

SEEDING SPECIFICATIONS

1. GRADING AND SHAPING

A. SLOPES SHALL NOT BE STEEPER THAN 2:1;3:1 SLOPES OR FLATTER ARE PREFERRED, WHERE MOWING WILL BE DONE, 3:1 SLOPES OR FLATTER ARE RECOMMENDED. 2 SEEDRED PREPARATION

L SEEDBED PREPARATION

A SUPFACE AND SEEPAGE WATER SHOULD BE DRAINED OR DIVERTED FROM THE SITE TO PREVENT DROWNING OR WINTER KILLING OF THE PLANTS.

B, STONES LARGER THAN 4 INCHES AND TRASH SHOULD BE REMOVED BECAUSE THEY INTERFERE WITH SEEDING AND FUTURE MAINTENANCE OF THE AREA WHERE FEASIBLE, THE SOIL SHOULD BE TILLED TO A DEPTH OF ABOUT 4 INCHES TO PREPARE A SEEDBED AND MIX FERTILIZER AND LIME INTO THE SOIL. THE SEEDBED SHOULD BE LETT IN REASONABLY FIRM AND SMOOTH CONDITION. THE LAST TILLAGE OPERATION SHOULD BE PERFORMED ACROSS THE SLOPE WHEREVER PRACTICAL.

3 FSTABLISHING A STAND

A. LIME AND FERTILIZER SHOULD BE APPLIED PRIOR TO OR AT THE TIME OF SEEDING AND INCORPORATED INTO THE SOIL KINDS AND AMOUNTS OF LIME AND FERTILIZER SHOULD BE BASED ON AN EVALUATION OF SOIL TESTS, WHEN A SOIL TEST IS NOT AVAILABLE, THE FOLLOWING MINIMUM AMOUNTS SHOULD BE APPLIED: AGRICULTURAL LIMESTONE, 2 TONS PER AGRE OR 100 LBS PER 1,000 SQ. FT...

NITROGEN(N), 50 LBS PER ACRE OR 1, 1 LBS PER 1,000 SQ.FT.

PHOSPHATE/P205), 100 LBS PER ACRE OR 2, 2 LBS PER 1,000 SQ.FT.

POTASH(K20), 100 LBS PER ACRE OR 2, 2 LBS PER 1,000 SQ.FT.

(NOTE: THIS IS THE EQUIVALENT OF 500 LBS PER ACRE OF 10-20-20 FERTILIZER OR 1,000 LBS PER ACRE OF 5-10-10.)

B. SEED SHOULD BE SPREAD UNIFORMLY BY THE METHOD MOST APPROPRIATE FOR THE SITE. METHODS INCLUDE BROADCASTING, DRILLING AND HYDROSEEDING. WHERE BROADCASTING IS USED, COVER SEED WITH .25 INCH OF SOIL OR LESS, BY CULTIPACKING OR RAKING.

C. REFER TO TABLE(G-E1 THIS SHEET) FOR APPROPRIATE SEED MIXTURES AND TABLE(H-E1 THIS SHEET) FOR RATES OF SEEDING. ALL LEGUMES (CROWN VETCH, BIRDS FOOT TREFOIL, AND FLAT PEA) MUST BE INOCULATED WITH THEIR SPECIFIC INOCULANT.

D. WHEN SEEDED AREAS ARE MULCHED, PLANTINGS MAY BE MADE FROM EARLY SPRING TO EARLY OCTOBER. WHEN SEEDED AREAS ARE NOT MULCHED, PLANTINGS SHOULD BE MADE FROM EARLY SPRING TO MAY 20 OR FROM AUGUST

4. MULCH

A. HAY, STRAW, OR OTHER MULCH, WHEN NEEDED, SHOULD BE APPLIED IMMEDIATELY AFTER SEEDING.

B. MULCH WILL BE HELD IN PLACE USING APPROPRIATE TECHNIQUES FROM THE BEST MANAGEMENT PRACTICE FOR MULCHING. HAY OR STRAW MULCH SHALL BE PLACED AT A RATE OF 90 LBS PER 1000 SQ. FT.

5. MAINTENANCE TO ESTABLISH A STAND

PLANTED AREA SHOULD BE PROTECTED FROM DAMAGE BY FIRE, GRAZING, TRAFFIC, AND DENSE WEED GROWTH.
FERTILIZATION NEEDS SHOULD BE DETERMINED BY ONSITE INSPECTIONS. SUPPLEMENTAL FERTILIZER IS USUALLY
THE KEY TO FULLY COMPLETE THE ESTABLISHMENT OF THE STAND BECAUSE MOST PERENNIAL STAKE 2 TO 3 YEARS TO
BECOME ESTABLISHED.


C. IN WATERWAYS, CHANNELS, OR SWALES WHERE UNIFORM FLOW CONDITIONS ARE ANTICIPATED, OCCASIONAL MOWING MAY BE RECESSARY TO CONTROL GROWTH OF WOODY VEGETATION.

NOTE: KEY STONE INTO CHANNEL BANKS AND EXTEND BEYOND ABUTMENTS A MINIMUM OF 18" TO PREVENT FLOW AROUND THE DAM. I = THE DISTANCE SUCH THAT POINTS A AND B ARE OF EQUAL ELEVATION. 2"-3" STONE FLOW SPACING BETWEEN STRUCTURES

MAINTENANCE
TEMPORARY GRADE STABILIZATION STRUCTURES SHOULD BE CHECKED AFTER EACH RAINFALL AND AT LEAST DALLY DURING PROLONGED STORMS. ANY NECESSARY REPAIRS SHOULD BE MADE IMMEDIATELY, PARTICULAR ATTENTION SHOULD BE GIVEN TO END RUN AND ERDSION AT THE DOWNSTREAM TO GO THE STRUCTURE. WHEN THE STRUCTURES ARE REMOVED, THE DISTURBED PORTION SHOULD BE GROUGHT TO THE EXISTING CHANNEL GRADE AND THE AREAS PERPARED, SECIOED AND MULCHED, WHILE THIS PRACTICE IS NOT INTENDED TO BE USED PRIMABILY FOR SEQUENT TRAPPING, SOME SEDIMENT THIL ACCUMULATE BEHING THE STRUCTURES. SEMIMENT SHALL BE REMOVED FROM BEHIND THE STRUCTURES WHEN IT HAS ACCUMULATED TO ONE HALF OF THE ORIGINAL HEIGHT OF THE STRUCTURE.

REMOVAL
AFTER VEGETATION HAS STABILIZED, THESE TEMPORARY STRUCTURES SHALL BE REMOVED WITH SPECIAL CARE
AS TO AVOID DISTURBING MAY UNDERLYING ROSSON CONTROL FABRIC AND/OR EXISTING VEGETATION

TEMPORARY STONE CHECK DAM

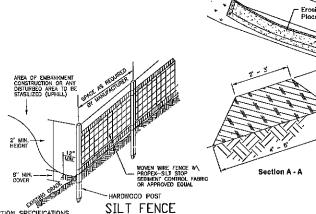

SILT FENCE

CONSTRUCTION SPECIFICATIONS

1. WOVEN WIRE FENCE TO BE FASTENED SECURELY TO FENCE POSTS WITH WIRE TIES OR STAPLES AND FILTER CLOTH SHALL BE FASTENED TO WOVEN WIRE EVERY 24" AT TOP MID AND BOTTOM SECTIONS AND BE EMBEDDED INTO GROUND A MINIMUM OF 8". 2. THE FENCE POSTS SHALL BE A MINIMUM 48" LONG, SPACED A MAXIMUM 10" APART, AND DRIVEN A

MINIMUM OF 16" INTO THE GROUND. 3. WHEN TWO SECTIONS OF FILER CLOTH ADJOIN EACH OTHER, THE ENDS OF THE FABRIC SHALL BE OVERLAPPED BY SIX INCHES, FOLDED AND STAPLED TO PREVENT SEDIMENT FROM

Mix material should consist of 30-50% large (1-3") particles. The organic matter content should be 25%-65%, dry weight basis. The organic matter may originate from a variety of vegetative sources, but needs to be fibrous and elongated. The mix shall be free of sitt clay, fina sand, refuse and contominants or any material toxic to plant growth. Erosion Control Mix berms are effective filters for overland flow conditions and should not be used to filter concentrated flow such as that found in drainage ditchs, streams, etc. Erosion Control Mix Berm

PREPARED FOR:

BEALS

Bare or vegel slope

Control Mix Ber

STONEARCH DEVEL. CORP. 42J DOVER POINT ROAD

DOVER, NH 03820

70 PORTSMOUTH AVE.

THIRD FLOOR, SUITE 2

STRATHAM, N.H. 03885

PHONE: 603-583-4860.

FAX 603-583-4863

Mix material should consist of 30-50%

SEEDING RATES POUNOS PER 1.000 Sq. Ft. POUNDS PER ACRE MIXTURE 0.45 0.45 0.05 0.95 HERSSING. . MAINTENANCE SHALL BE PERFORMED AS NEEDED AND SEDIMENT REMOVED WHEN "BULGES" 4. MANIENANCE SHALL BE PERFORMED AS DIEDUED AND SEDMENT REMOVED WHEN BUILDED DEVELOP IN THE SILT FENCE AND PROPERTY DISPOSED OF.

5. PLACE THE ENDS OF THE SILT FENCE UP CONTOUR TO PROVIDE FOR SEDMENT STORAGE.

6. SILT FENCES SHALL BE REMOVED WHEN NO LONGER NEEDED AND THE SEDMENT COLLECTED SHALL BE DISPOSED AS DIRECTED BY THE ENGINEER. THE AREA DISTURBED BY THE REMOVAL SHALL BE SMOOTHED AND RE-VEGETATED. : TALL FESCUE CREEPING RED FESCUE CROWN VETCH OR FLAT PEA TOTAL 0.35 0.25 0.35 0,75 0.95 OR 1.35 40 OR 55 TALL FESCUE
CREEPING RED FESCUE
BIRDS FOOT TREFOIL
TOTAL *). Tall Fescue Flat Pea Total 0,45 0,75 1,20 CREEPING RED FESCUE 1/2
KENTUCKY BLUEGRASS 1/2
TOTAL 1,15 1,15 2,30

F. TALL FESCUE 1 3.60

FEB DO TON REVISIONS: DATE:

1/ FOR HEAVY USE ATHLETIC FIELDS CONSULT THE UNIVERSITY ON NEW HAMPSHIRE COOPERATIVE EXTENSION TURF SPECIALIST FOR CHARGET WARRIFLES AND SECOND RATES.

EROSION, & SEDIMENTATION FOR:

COMMERCIAL DEVELOPMENT ROUTE 125 BARRINGTON, NH

SCALE: DATE: FEB 2022 NONE NH-1144.1 SHEET NO. PROJ. NO:

MAINTENANCE

1. SILT FENCES SHALL BE INSPECTED IMMEDIATELY AFTER EACH RAINFALL AND AT LEAST DAILY DURING PROLONGED RAINFALL. ANY REPAIRS THAT ARE REQUIRED SHALL BE MADE IMMEDIATELY.

2. IF THE FABRIC ON A SILT FENCE SHOULD DECOMPOSE OR BECOME INEFFECTIVE DURING THE EXPECTED LIFE OF THE FENCE, THE FABRIC SHALL BE REPLACED PROMPTLY.

3. SEDIMENT DEPOSITS SHOULD BE INSPECTED AFTER EVERY STORM EVENT. THE DEPOSITS SHOULD BE REMOVED WHEN THEY REACH APPROXIMATELY ONE HALF THE HEIGHT OF THE BARRIER. BARRIER. 4. SEDIMENT DEPOSITS THAT ARE REMOVED OR LEFT IN PLACE AFTER THE FABRIC HAS BEEN REMOVED SHALL BE GRADED TO CONFORM WITH THE EXISTING TOPOGRAPHY AND VEGETATED. SEEDING GUIDE

SEEDING MIXTURE 1/ DROUGHTY WELL DRAINED USE GOOD GOOD GOOD FAIR EXCELLENT STEEP CUTS AND FILLS, BORROW AND DISPOSAL AREAS GOOD FAIR EXCELLENT GOOD EXCELLENT FAIR FAIR GOOD EXCELLE POOR FAIR POOR POOR FAIR WATERWAYS, EMERGENCY SPILLWAYS, AND OTHER CHANNELS WITH FLOWING WATER. LIGHTLY USED PARKING LOTS, ODD AREAS, UNUSED LANGS, AND LOW INTENSITY USE RECREATION SITES. PLAY AREAS AND ATHLETIC FIELDS. (TOPSOIL IS ESSENTIAL FOR GOOD TURF.) FAIR FAIR EXCELLENT EXCELLENT EXCELLENT

GRAVEL PIT, SEE NH-PM-24 IN APPENDIX FOR RECOMMENDATION REGARDING RECLAMATION OF SAND AND GRAVEL PITS. 1/ refer to seeding mixtures and rates in Table 7-36.
27 poorly drained soils are not desirable for use as playing area and athletic fields.

NOTE: TEMPORARY SEED MIX FOR STABILIZATION OF TURF SHALL DE WINTER RYE OR DATS AT A RATE OF 2.5 LBS. PER 1000 S.F. AND SHALL BE PLACED PRIOR TO OCT. 15, IF PERMANENT SEEDING NOT YET COMPLETE.